


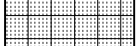
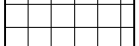

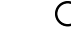
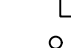





# LEGEND


-  INDICATES EXTENT OF DEM 01:  
DEMOLITION OF PVC ROOFING ON CONCRETE/GYPSUM DECK
-  INDICATES EXTENT OF DEM 02:  
DEMOLITION OF HYBRID ROOFING ON METAL DECK
-  INDICATES EXTENT OF DEM 03:  
DEMOLITION OF CONCRETE TOPPING SLAB AND WATERPROOFING ON CONCRETE DECK
-  INDICATES EXTENT OF DEM 04:  
DEMOLITION OF PVC ROOFING AND PAVERS ON CONCRETE DECK
-  INDICATES EXTENT OF DEM 05:  
DEMOLITION OF PVC ROOFING AND PAVERS ON CONCRETE FILL
-  INDICATES EXISTING ROOF DRAIN
-  INDICATES EXISTING PIPE PENETRATION TO REMAIN
-  INDICATES EXISTING 'REGULAR SHAPE', TUBE, STEEL PEDESTAL PENETRATION TO REMAIN
-  INDICATES EXISTING MECHANICAL UNITS TO REMAIN
-  INDICATES EXISTING RAILING TO REMAIN
-  INDICATES ROOF AREA NUMBER

# DEMOLITION NOTES

- CONTRACTOR SHALL REMOVE & DISPOSE OF ALL EXISTING MEMBRANES, WOOD BLOCKING, VAPOR RETARDANTS, INSULATION, FLASHING & RELATED MATERIALS DOWN TO THE CONCRETE / METAL DECK (EXCEPT WHERE INDICATED TO REMAIN IN THE ASSOCIATED RESTORATION ASSEMBLY DETAIL).
- CONTRACTOR SHALL REMOVE & DISPOSE OF ALL EXISTING PITCH POCKETS AND RELATED ACCESSORIES.
- COORDINATE WITH ALL TRADES TO ENSURE ROOF SYSTEM REMAINS WATER TIGHT THROUGHOUT CONSTRUCTION.
- EXISTING DRAINS, SUPPORTS, PIPES AND VENTILATORS TO BE MADE WATER TIGHT IN THEIR EXISTING CONFIGURATION AFTER ROOFING DEMOLITION. SEE ROOF PLAN FOR LOCATIONS AND MODIFICATION REQUIREMENTS FOR FINAL ROOF INSTALLATION.
- CONTRACTOR SHALL PROTECT EXISTING MECHANICAL EQUIPMENT DURING DEMOLITION OF EXISTING ROOFING & INSTALLATION OF NEW ROOFING.
- ALL EXISTING ROOFTOP ELECTRICAL/MECHANICAL EQUIPMENT/CONDUIT INTERFERING WITH INSTALLATION OF NEW ROOFTOP SYSTEM IS TO BE TEMPORARILY DISCONNECTED, ADJUSTED AND RECONNECTED UPON COMPLETION OF WORK BY A NYC LICENSED ELECTRICIAN.
- TEMPORARILY DISCONNECT EXISTING CONDUITS AND PIPES AS REQUIRED TO INSTALL NEW ROOF AND FLASHING; RECONNECT AFTER NEW ROOF AND FLASHING IS IN PLACE; RECONNECTION SHALL BE DONE BY NYS LICENSED PLUMBER/ELECTRICIAN AND COORDINATED WITH FACILITIES (TYP.)
- PROVIDE NEW CONDUIT/PIPING SUPPORTS APPROVED BY ROOFING SYSTEM MANUFACTURER
- ALL COSTS RELATED TO DISCONNECTING, RESETING, REPLACEMENT, REPAIR AND RECONNECTING OF EXISTING CONDUITS/PIPING SHALL BE INCLUDED IN BASE BID.
- AT TERRACE #11 & #13 DISCONNECT EXISTING DEFUNCT SNOW MELTING COILS EMBEDDED IN EXISTING CONCRETE TOPPING SLAB PRIOR TO BEGINNING OF WORK AT THOSE AREAS. (BUILDING ENTRANCE DOORS)
- COORDINATE WITH BUILDING FACILITY REGARDING DISCONNECTION OF COILS AND ELECTRICAL PANEL LOCATION.


# RESTORATION SCHEDULE

ID CODE	RESTORATION ITEM	DWG.
CON 01	Concrete Deck Repair / Fill	A-501
DCK 01	Metal Deck Repair	A-501
DEM 01	Demolition: PVC Roofing on Conc./Gypsum Deck	DM-102
DEM 02	Demolition: Hybrid Roofing on Metal Deck	DM-102
DEM 03	Demolition: Conc. Topping Slab/W.P. on Conc. Deck	DM-102
DEM 04	Demolition: PVC Roofing/Pavers on Conc. Deck	DM-102
DEM 04	Demolition: PVC Roofing/Pavers on Conc. Fill	DM-102
FIL 01	Concrete deck negative slope repair / fill	A-501
PCH 01	Gypsum deck repair	A-501
PCH 02	Roof Membrane Patch: Built-up Roofing	A-503
JNT 01	Sealant Replacement	A-524

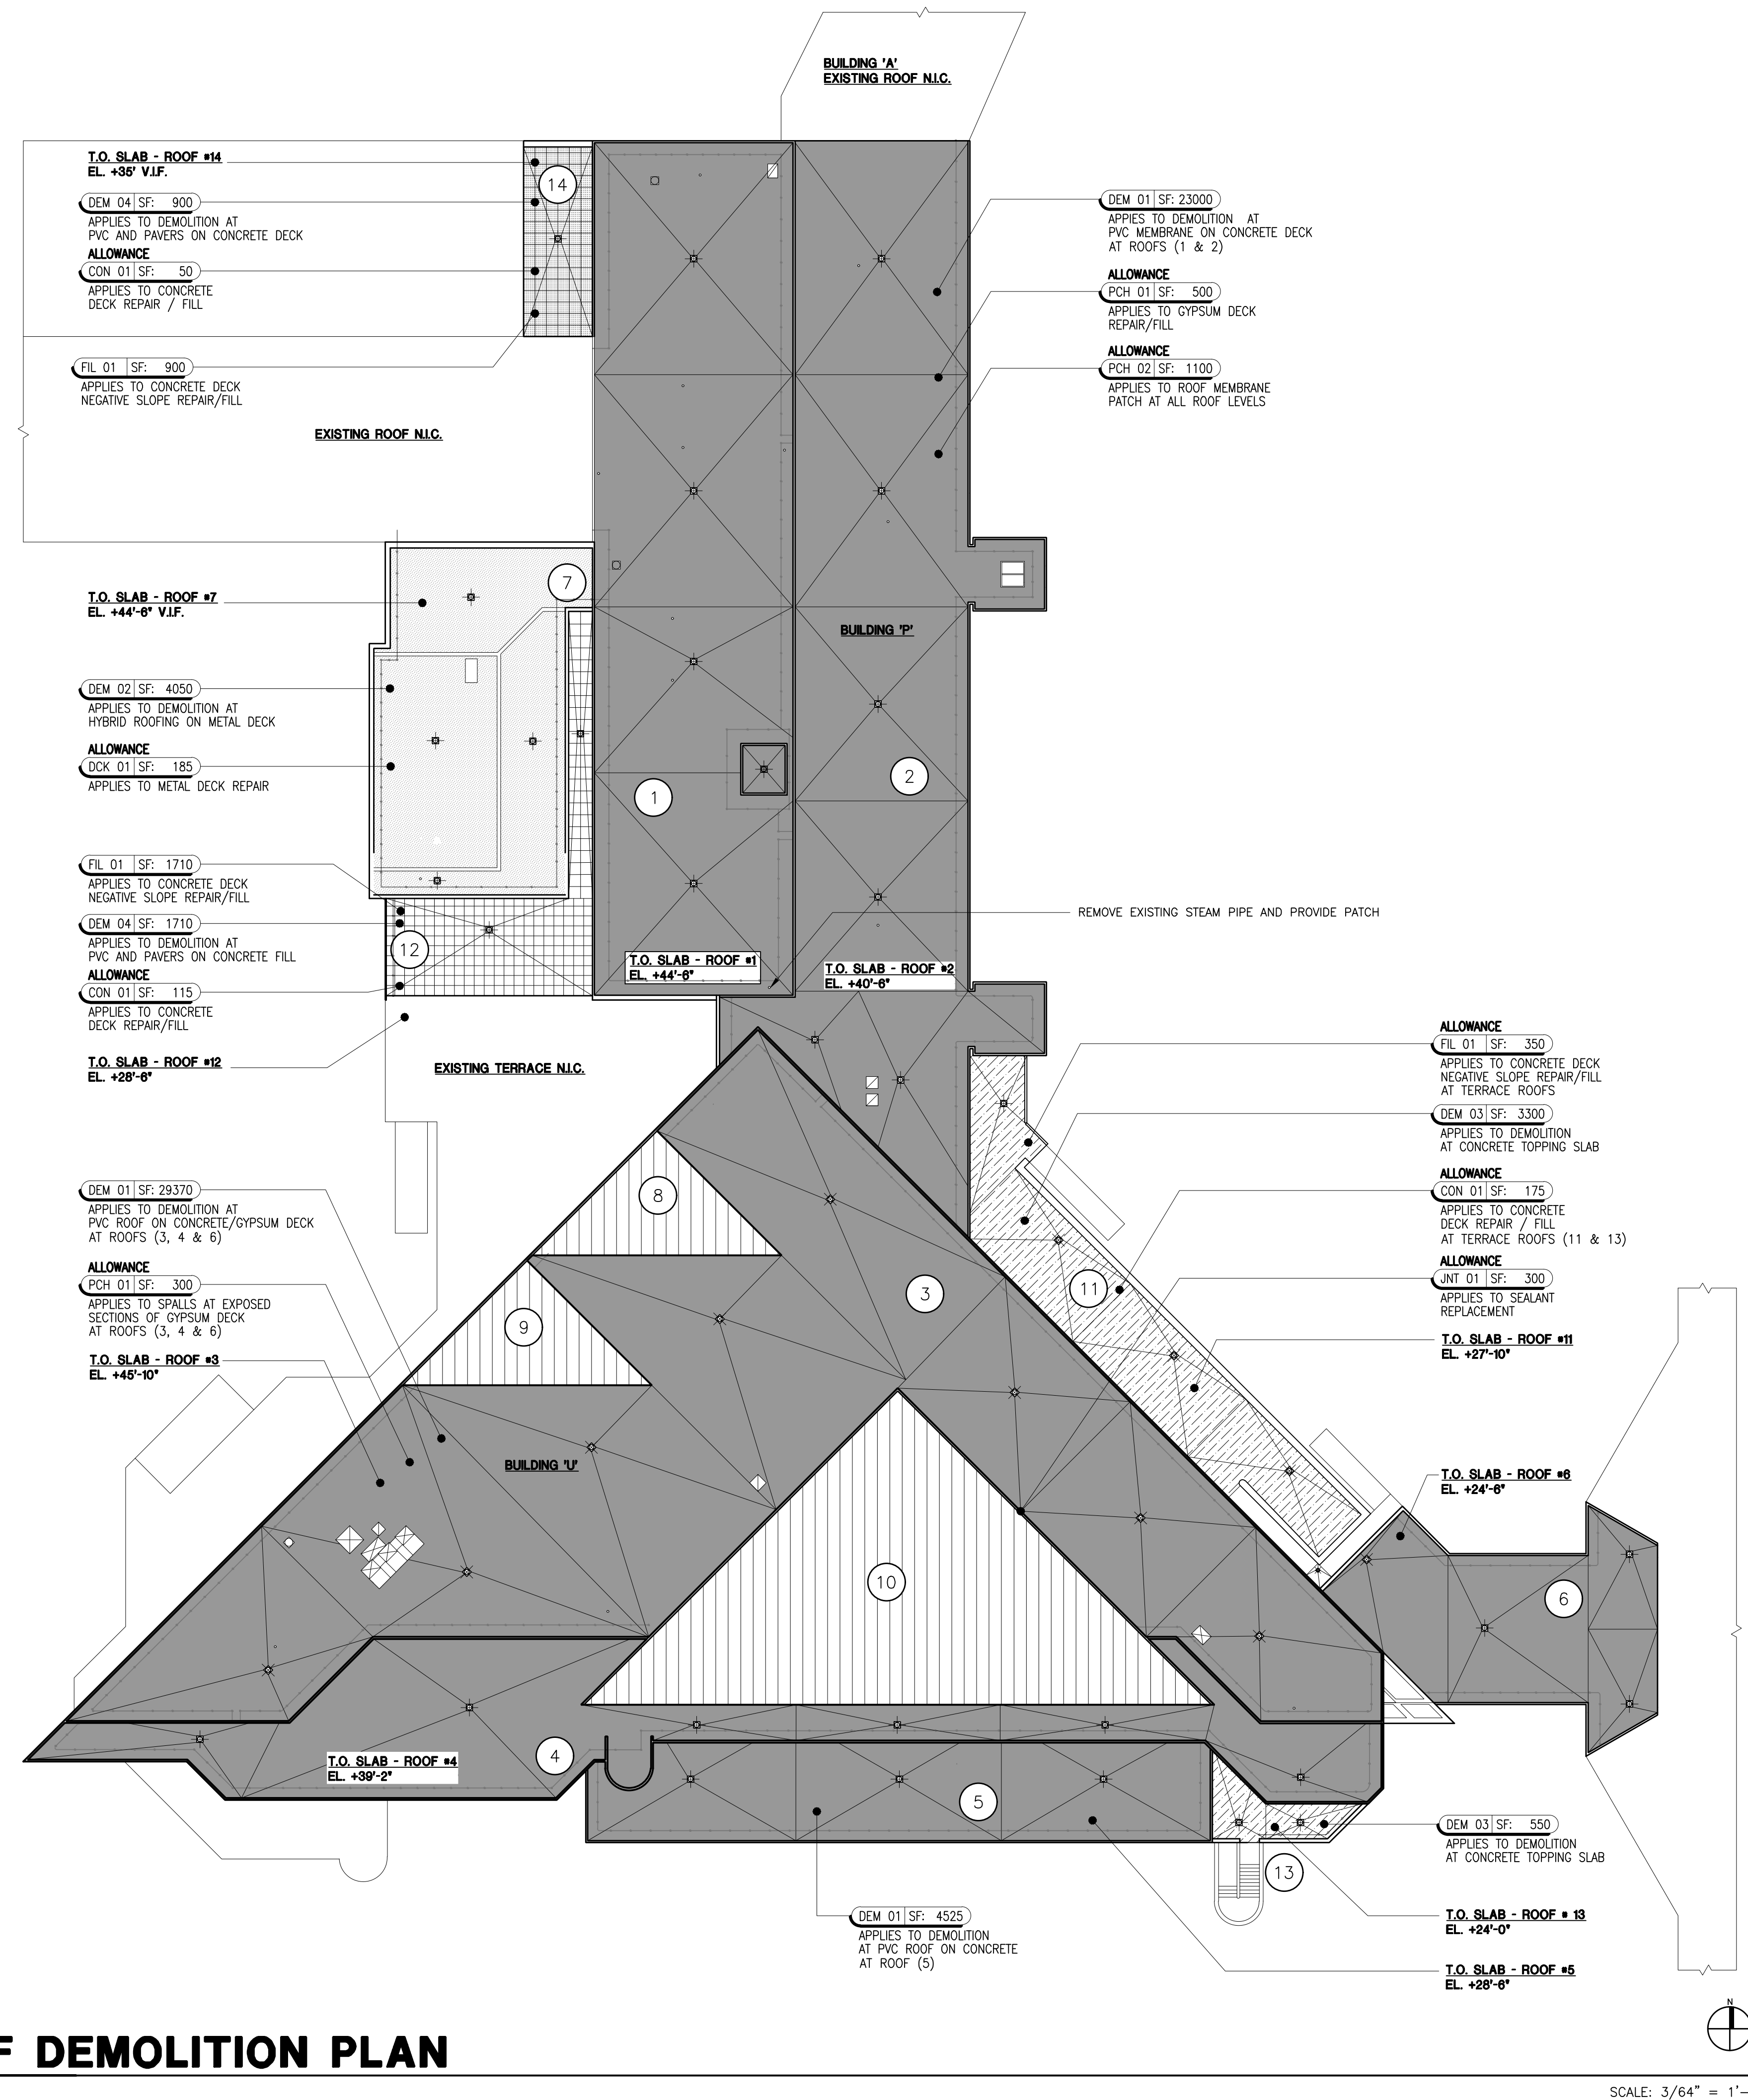


# ROOF DEMOLITION PLAN

SCALE: 3/64" = 1'-0"

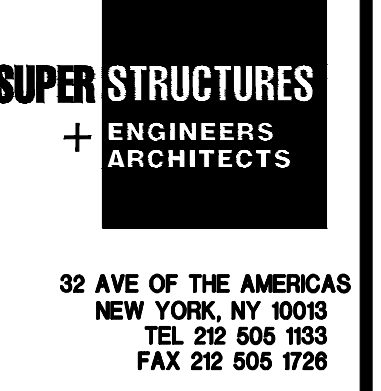

### Project Key

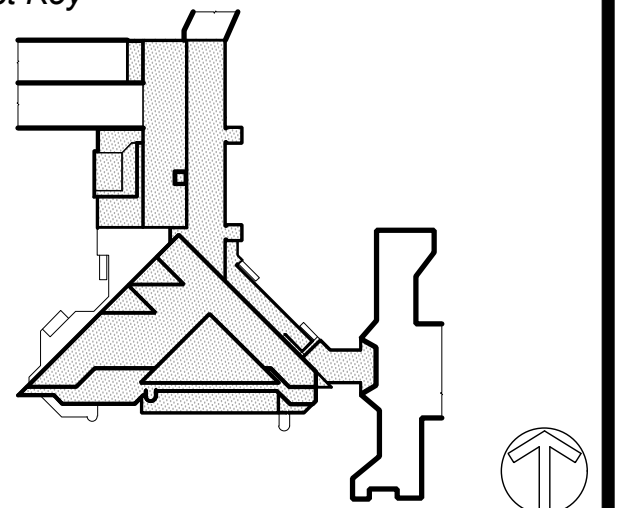

### Phase

### Revisions

Number	Description	Date

### Project Title

# ROOF REPLACEMENT BUILDINGS "U" AND "P"

Drawn By: \_\_\_\_\_ Checked By: \_\_\_\_\_ Date: \_\_\_\_\_ DASNY Project No: \_\_\_\_\_

### Sheet Title

### Sheet Number

# DM-101.00

DOB Employee Stamp and Signatures:

DOB Scan Sticker